
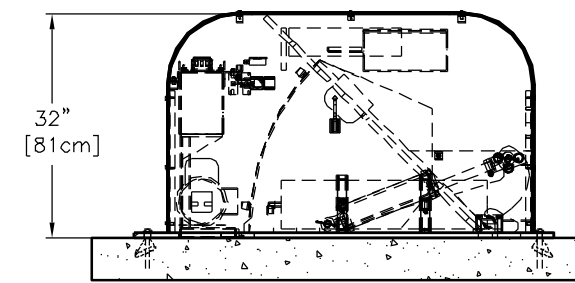


NOMINAL BARRIER WIDTH (ft.)	DIM. "A" (in.)	DIM. "A" (cm)	DIM. "B" (in.)	DIM. "B" (cm)	TOTAL BARRIER WEIGHT (lbs)	TOTAL BARRIER WEIGHT PER SQUARE FOOT
10 ft	120 in	305 cm	160 in	406 cm	3,000 lbs	45 lbs/sq. ft.
11 ft	132 in	335 cm	172 in	437 cm	3,225 lbs	45 lbs/sq. ft.
12 ft	144 in	366 cm	184 in	467 cm	3,450 lbs	45 lbs/sq. ft.
13 ft	156 in	396 cm	196 in	498 cm	3,675 lbs	45 lbs/sq. ft.
14 ft	168 in	427 cm	208 in	528 cm	3,900 lbs	45 lbs/sq. ft.

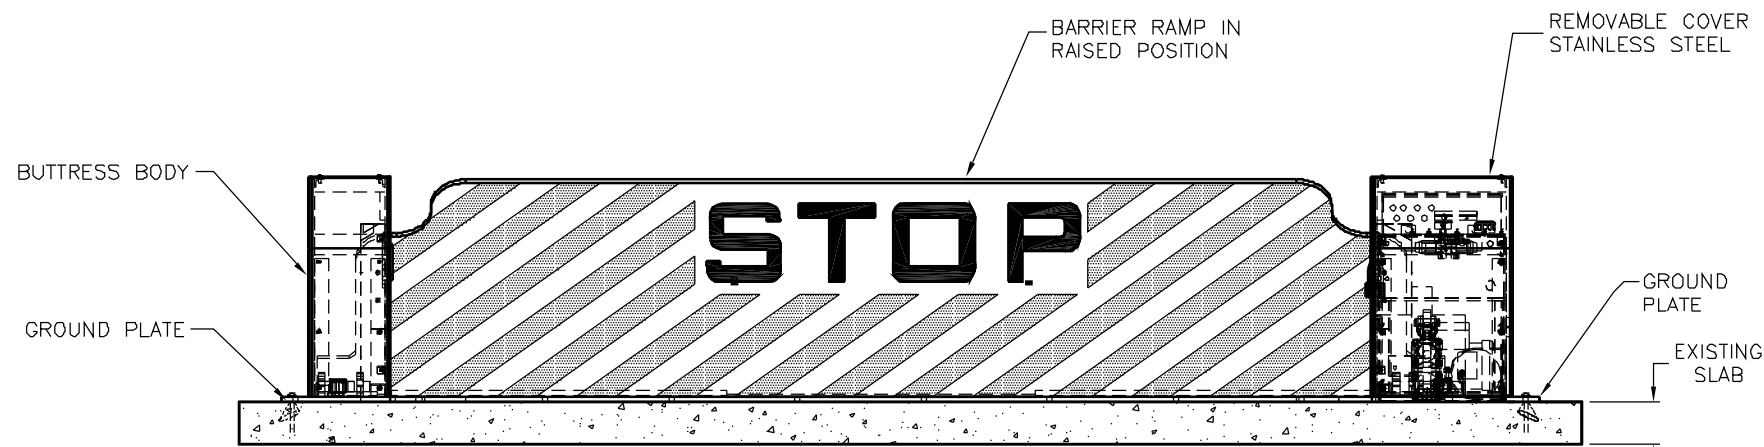

FRONT ELEVATION (UNPROTECTED SIDE)

SIDE ELEVATION

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		DSC1400 HYDRAULIC BARRIER SYSTEM GENERAL ARRANGEMENT			
		<small>DELTA</small>	<small>TOLERANCES</small> X = ±.060/FT XX = ±.030/FT XXX = ±.010/FT ANGLES = ±.5°	<small>SLURFACE FINISH</small> 125	<small>REMOVE ALL BURRS & BREAK SHARP EDGES .02 MAX</small>
		<small>© 2008 ALL RIGHTS RESERVED</small>	<small>APPROVED BY</small>	<small>DATE</small>	<small>SCALE: 1:16 (D SIZE)</small>
<small>DRWN BY</small> J. MANDR	<small>DATE</small> 2/24/09	<small>DRAWING NO.</small> 90409	<small>REV.</small> A		
<small>CHKD BY</small>	<small>DATE</small>	<small>SHEET</small>	<small>1 OF 1</small>		